

Independence and Larimer Park Renovations

Bid # 24-06

ADDENDUM No. 1

March 6, 2024

Any and all changes to the Contract Document are valid only if they are included by written addendum to all potential respondents, which will be mailed, emailed and/or faxed prior to the bid due date to all who are known to have received a complete bid document. Each respondent must acknowledge receipt of any addenda by indicating on the Bid Form. Each respondent, by acknowledging receipt of any addenda, is responsible for the contents of the addenda and any changes to the bid proposal therein. Failure to acknowledge receipt of any addenda may cause the bid to be rejected. If any language or figures contained in this addendum are in conflict with the original document, this addendum shall prevail.

This addendum consists of the following:

1. Addendum Number One (1) is attached and consists of a total of seven (7) pages including this cover sheet. Any changes to the drawings or specifications noted within Addendum Number One (1) will be reflected in subsequent drawing issues.

Please feel free to call (847-866-2910) or email (<u>lithomas@cityofevanston.org</u>) with any questions or comments.

Sincerely,

Linda Thomas Purchasing Specialist

Independence and Larimer Park Renovations

Bid # 24-06

ADDENDUM No. 1

March 6, 2024

This addendum forms a part of the Specifications and Bid Documents for Bid #24-06 and modifies these documents. This addendum consists of the following:

Drawings:

Sheet C203: Grading Plan

Grades have been revised at the northwest cul-de-sac ada ramp

Sheet C204, Detail 1: Grading Plan ADA Details

Grades have been revised at the northwest cul-de-sac ada ramp

Sheet L301, Detail 1: Tree Grate at Plaza

- Depth of tree rootball has been revised
- · Tree uplight footing has been revised

Sheet L301, Detail 2: Tree Grate – At Existing Curb

Depth of tree rootball has been revised

Sheet L304, Detail 5: Backstop – Side Elevation

- Overall height of backstop has been revised
- · Quantity and spacing of horizontal rails has been revised


Sheet L304, Detail 6: Backstop – Back Elevation

- Overall height of backstop has been revised
- Quantity and spacing of horizontal rails has been revised
- One vertical post has been added

Sheet L310, Detail 4: Tree Planting in Tree Grate

Depth of tree rootball has been revised

Note: Acknowledgment of this Addendum is required in the Bid.

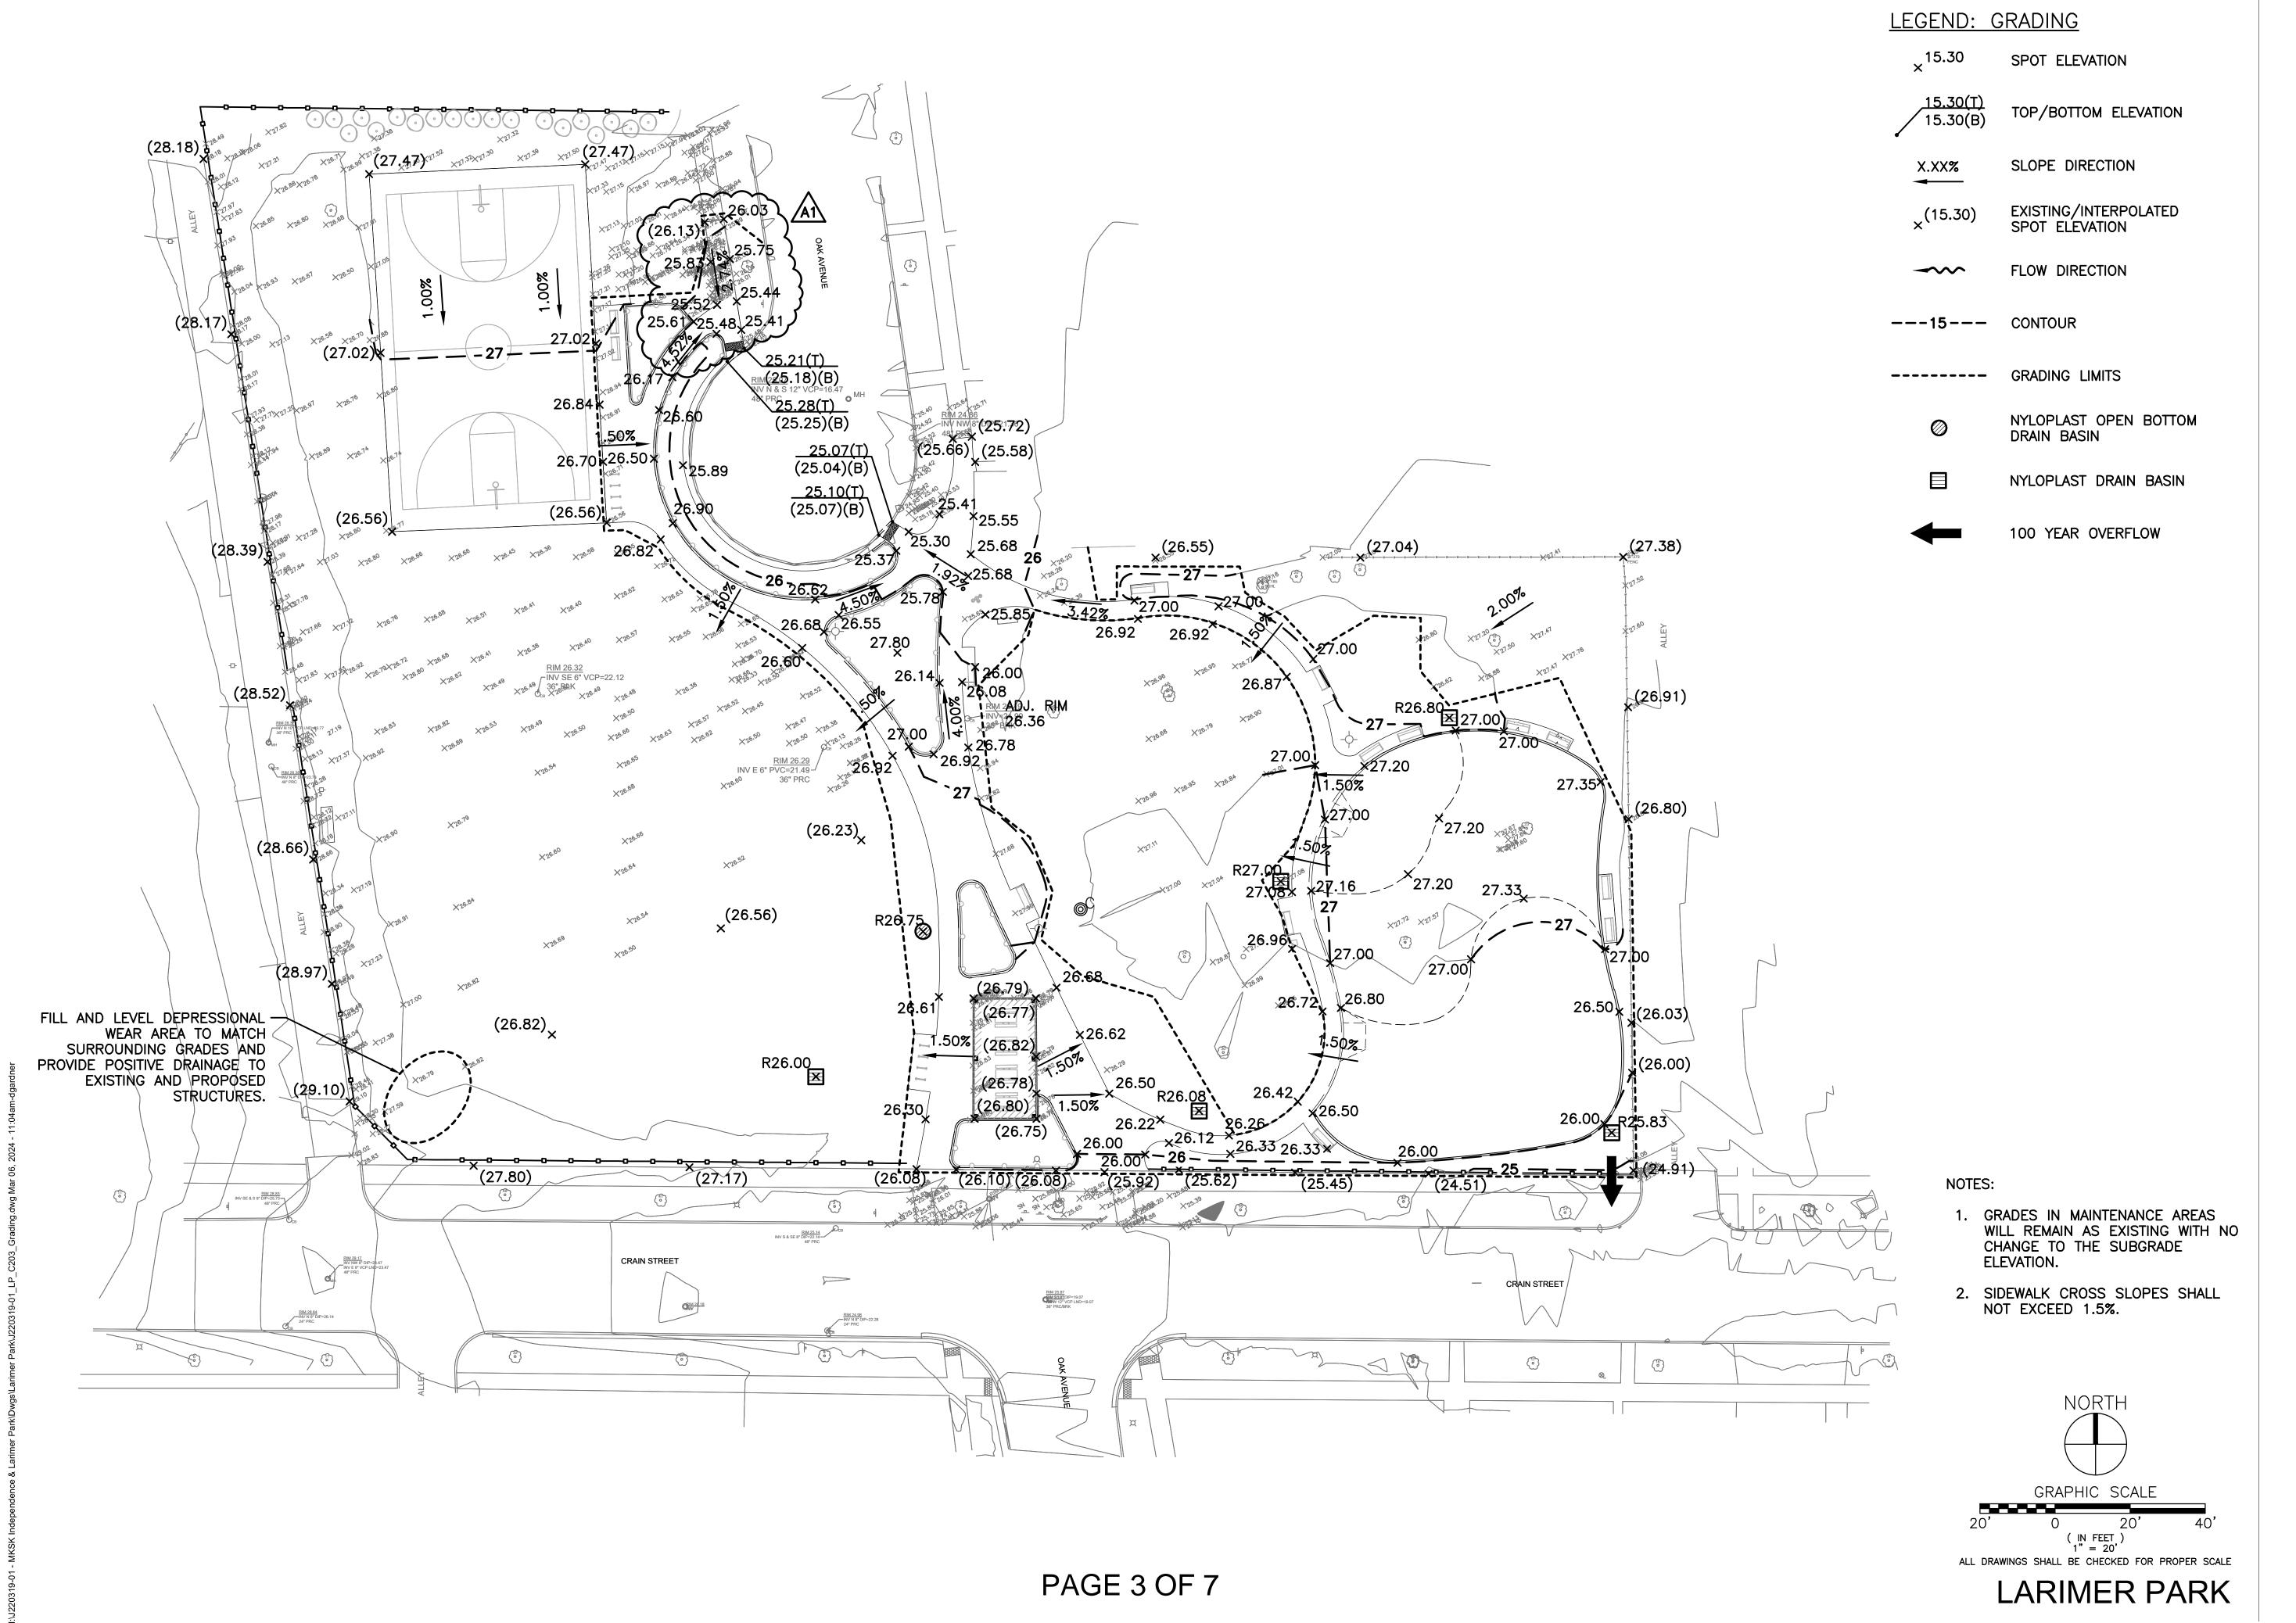

MKSK

Landscape Architecture
Urban Design
Planning

3057 NORTH ROCKWELL STREET CHICAGO, IL 60618 312.809.9707 MKSKSTUDIOS.COM

client / owner
City of Evanston, IL

INDEPENDENCE AND LARIMER PARK

RENOVATIONS project address

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Electrical Engineer

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Architect for Larimer Park

Booth Hansen 333 South Desplaines Street Chicago, IL 60661 p 312 869.5000

ISSUE FOR BID

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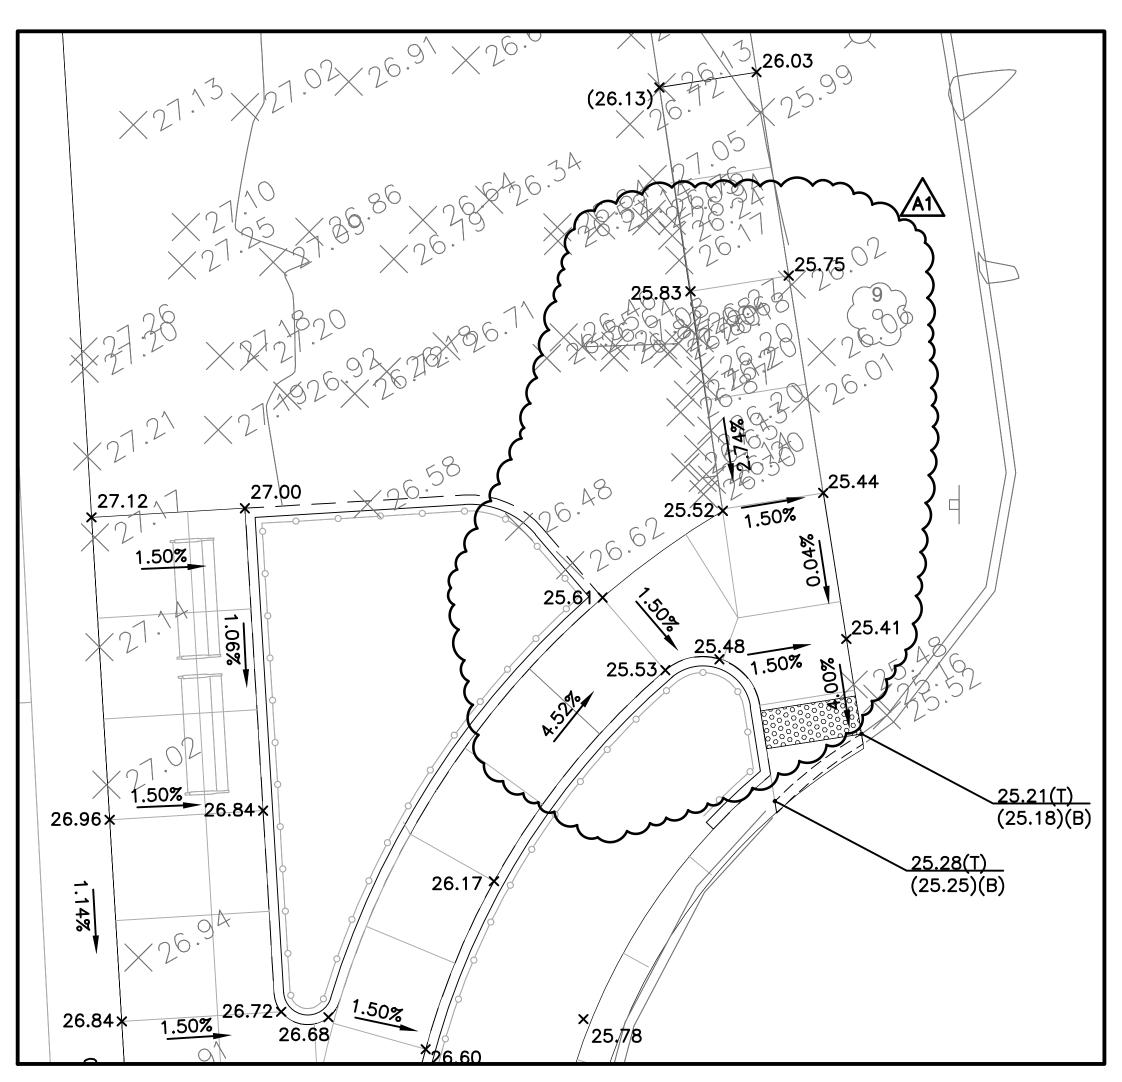
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n22229

GRADING PLAN


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C203




NORTHWEST CUL-DE-SAC ADA RAMP

SCALE: 1"=5"

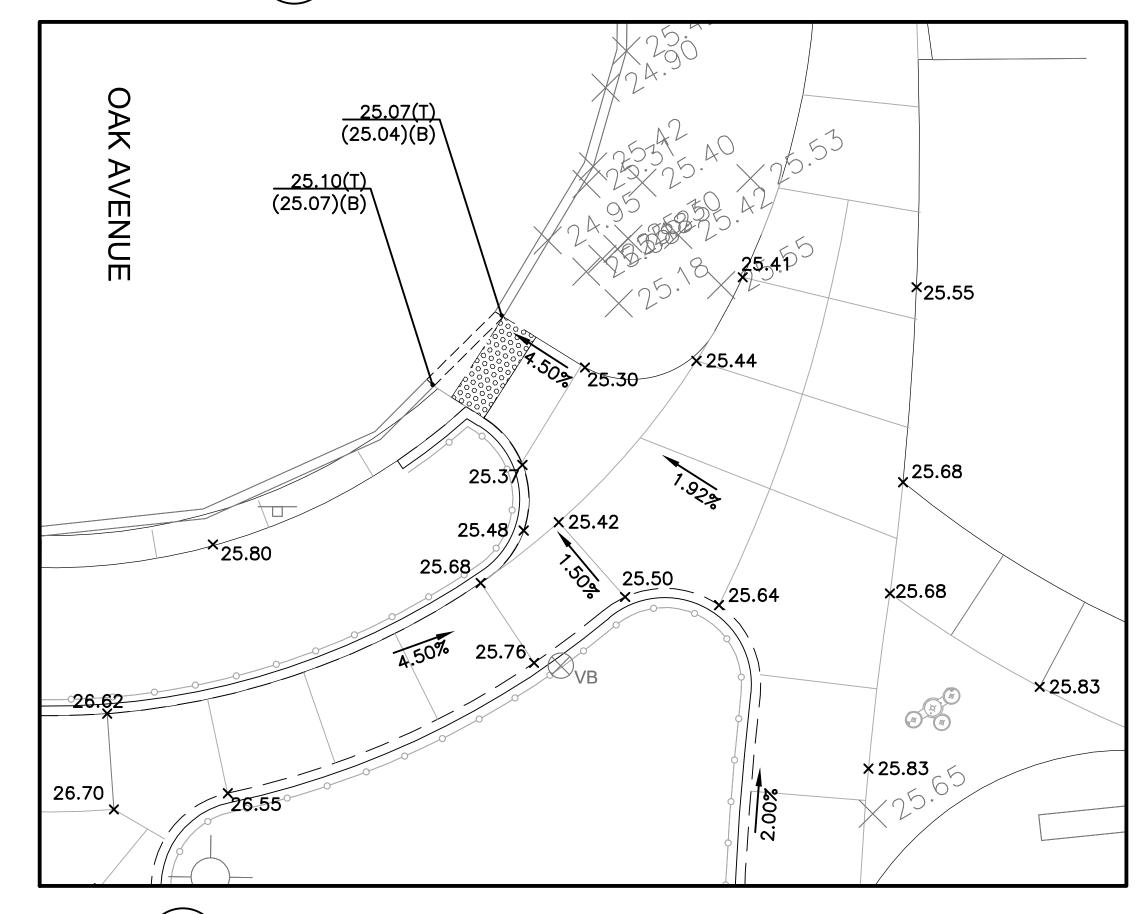

SCALE: 1"=5'

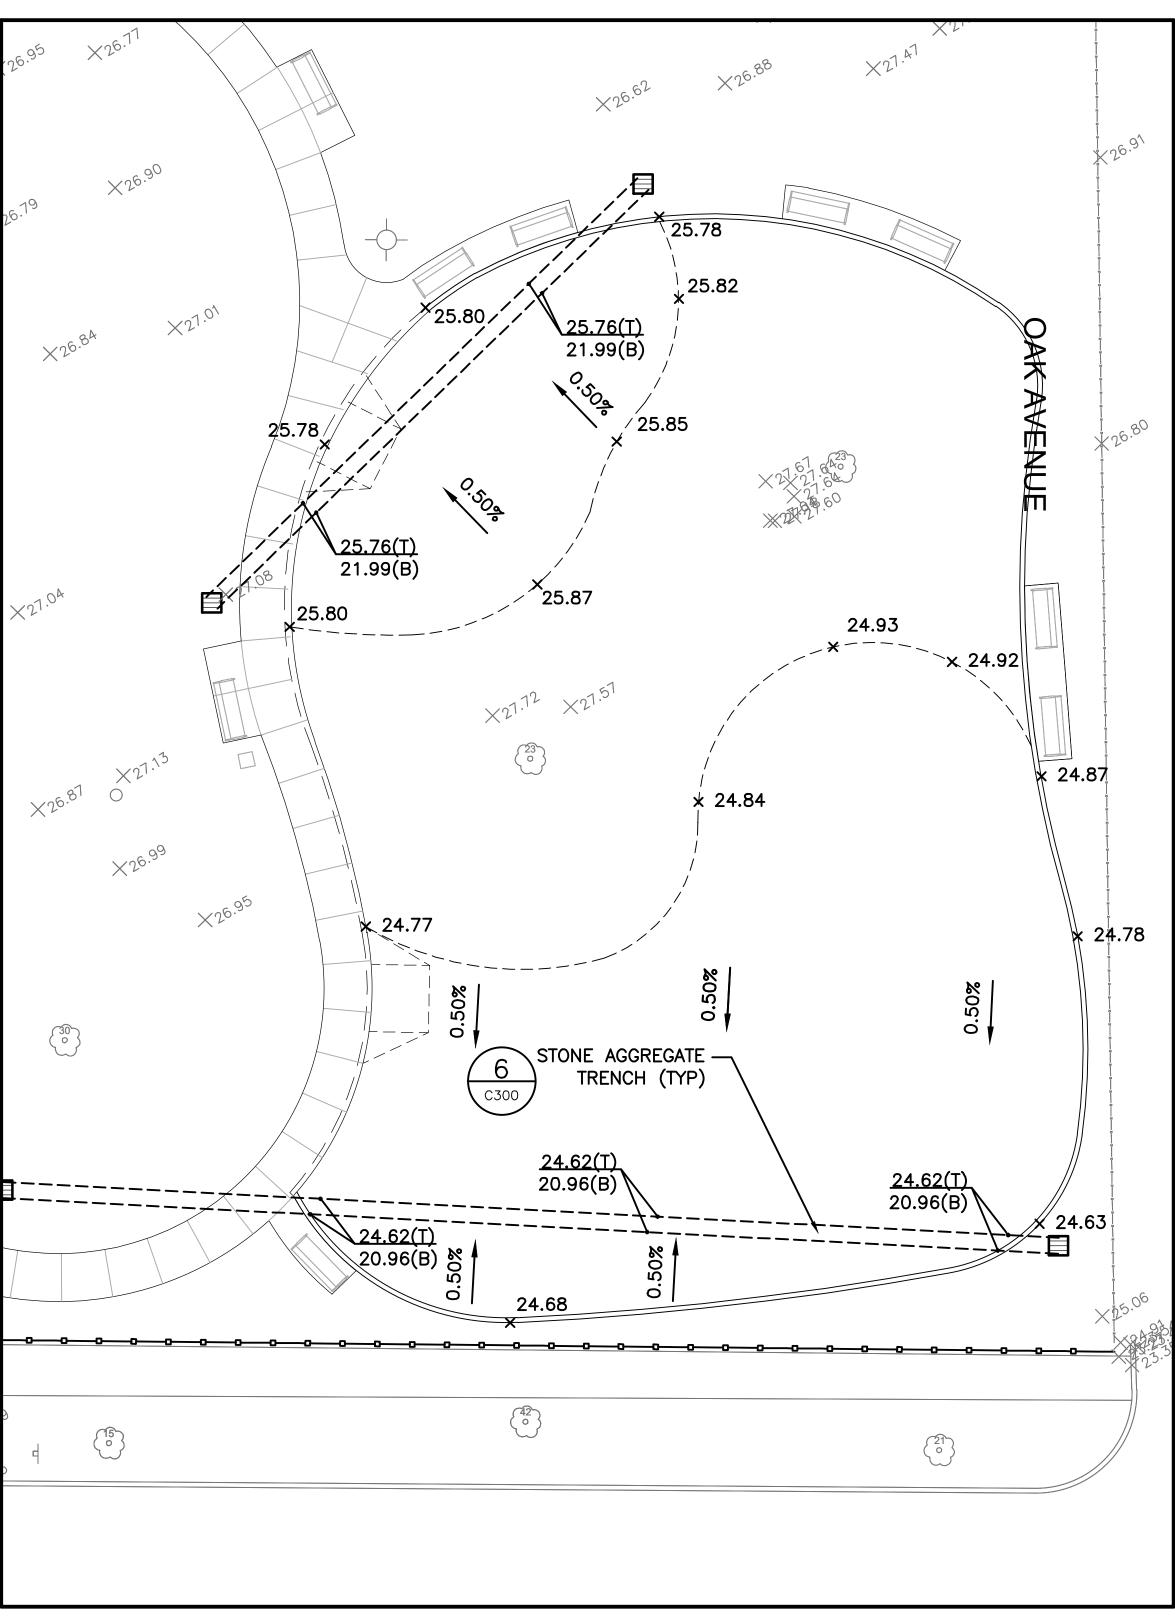

3 EXCAVATION PLAN
C204 SCALE: 1"=10"

x15.30 SPOT ELEVATION

15.30(T)
15.30(B)
TOP/BOTTOM ELEVATION

X:XX%
SLOPE DIRECTION

(15.30)
EXISTING/INTERPOLATED
SPOT ELEVATION

TRENCH

CATCH BASIN

NYLOPLAST DRAIN BASIN

CLEANOUT

LEGEND: GRADING / EXCAVATION

ISSUE FOR BID

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p 312 884.5100 Electrical Engineer

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LARIMER PARK

RENOVATIONS

David Mason & Associates Inc

Delta Engineering Group, LLC

Environmental Consulting Group

INDEPENDENCE AND

2001 CENTRAL STREET EVANSTON, IL 60202 1101 CRAIN STREET EVANSTON, IL 60202

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2 11.03.2023 70% CONSTRUCTION DOCUME

3 12.22.2023 100% CONSTRUCTION DOCUME

4 02.15.2023 ISSUE FOR BID

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GRADING PLAN
ADA DETAILS

C204

GRAPHIC SCALE


20' 0 20' 40'


(IN FEET,)

1" = 20'

ALL DRAWINGS SHALL BE CHECKED FOR PROPER SCALE

LARIMER PARK

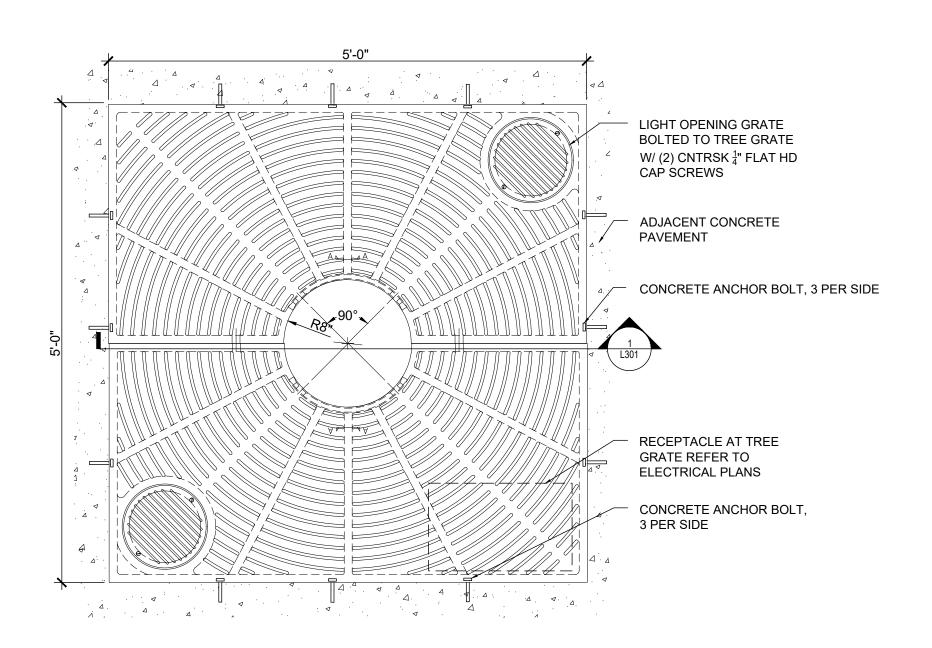

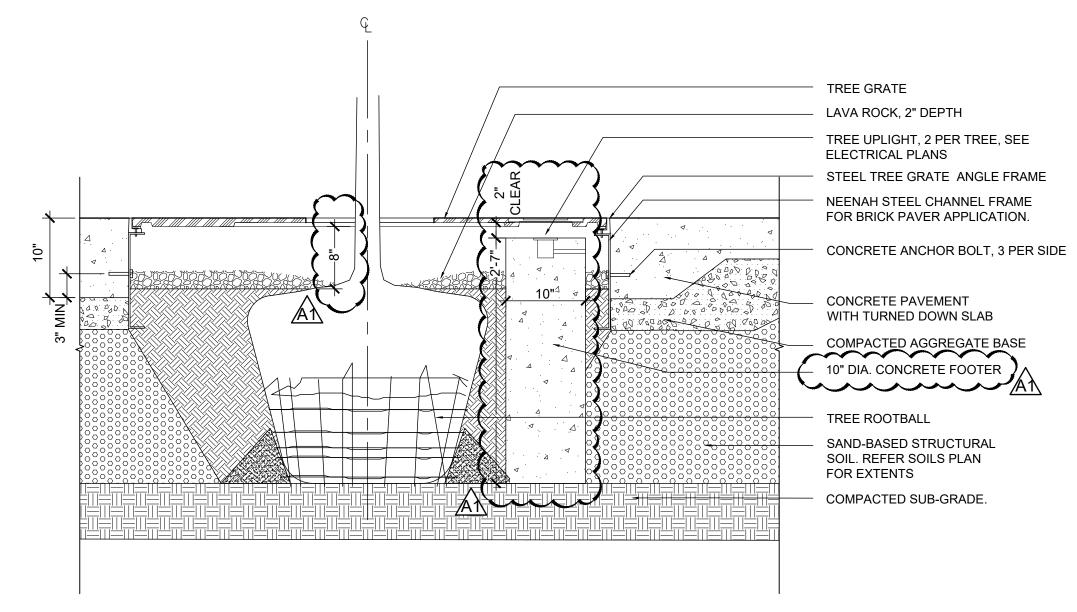

EXISTING ASPHALT ROADWAY. DO

EXISTING CURB. DO NOT DISTURB

DETECTABLE WARNING SURFACE

COMPACTED AGGREGATE BASE

COMPACTED SUBGRADE

CONCRETE PAVEMENT - PEDESTRIAN

TRANSITION TO ADJACENT

CONCRETE PAVEMENT


NOT DISTURB.

EXPANSION JOINT

TREE GRATE AT PLAZA 1 SCALE: 1" = 1'-0"

<u>SECTION</u>


3 ADA TACTILE PAVING SCALE: 1" = 1'-0"

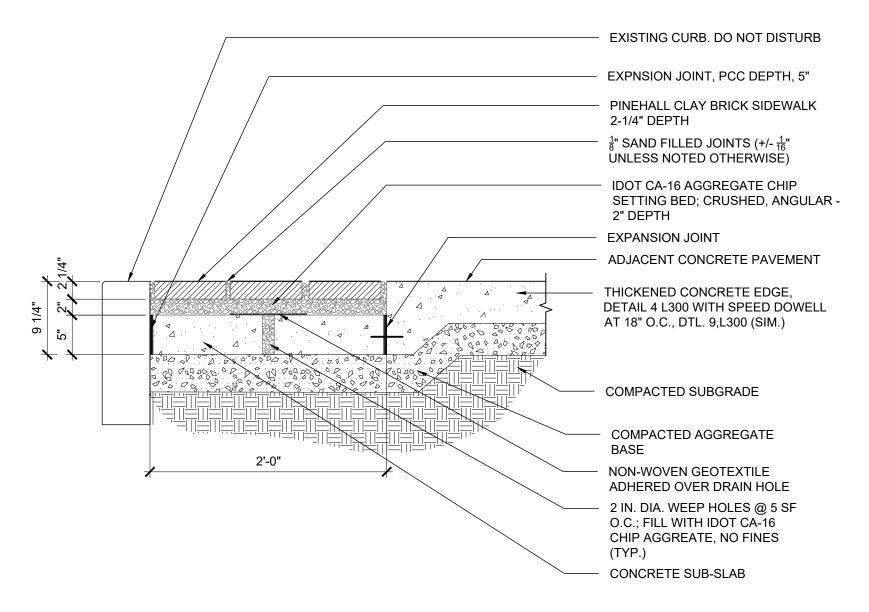


BRICK PAVER SIDEWALK

SCALE: 1" = 1'-0"

5 CONCRETE CURB ADJACENT CONC. PVMT & LANDSCAPE
SCALE: 1 1/2" = 1'-0"

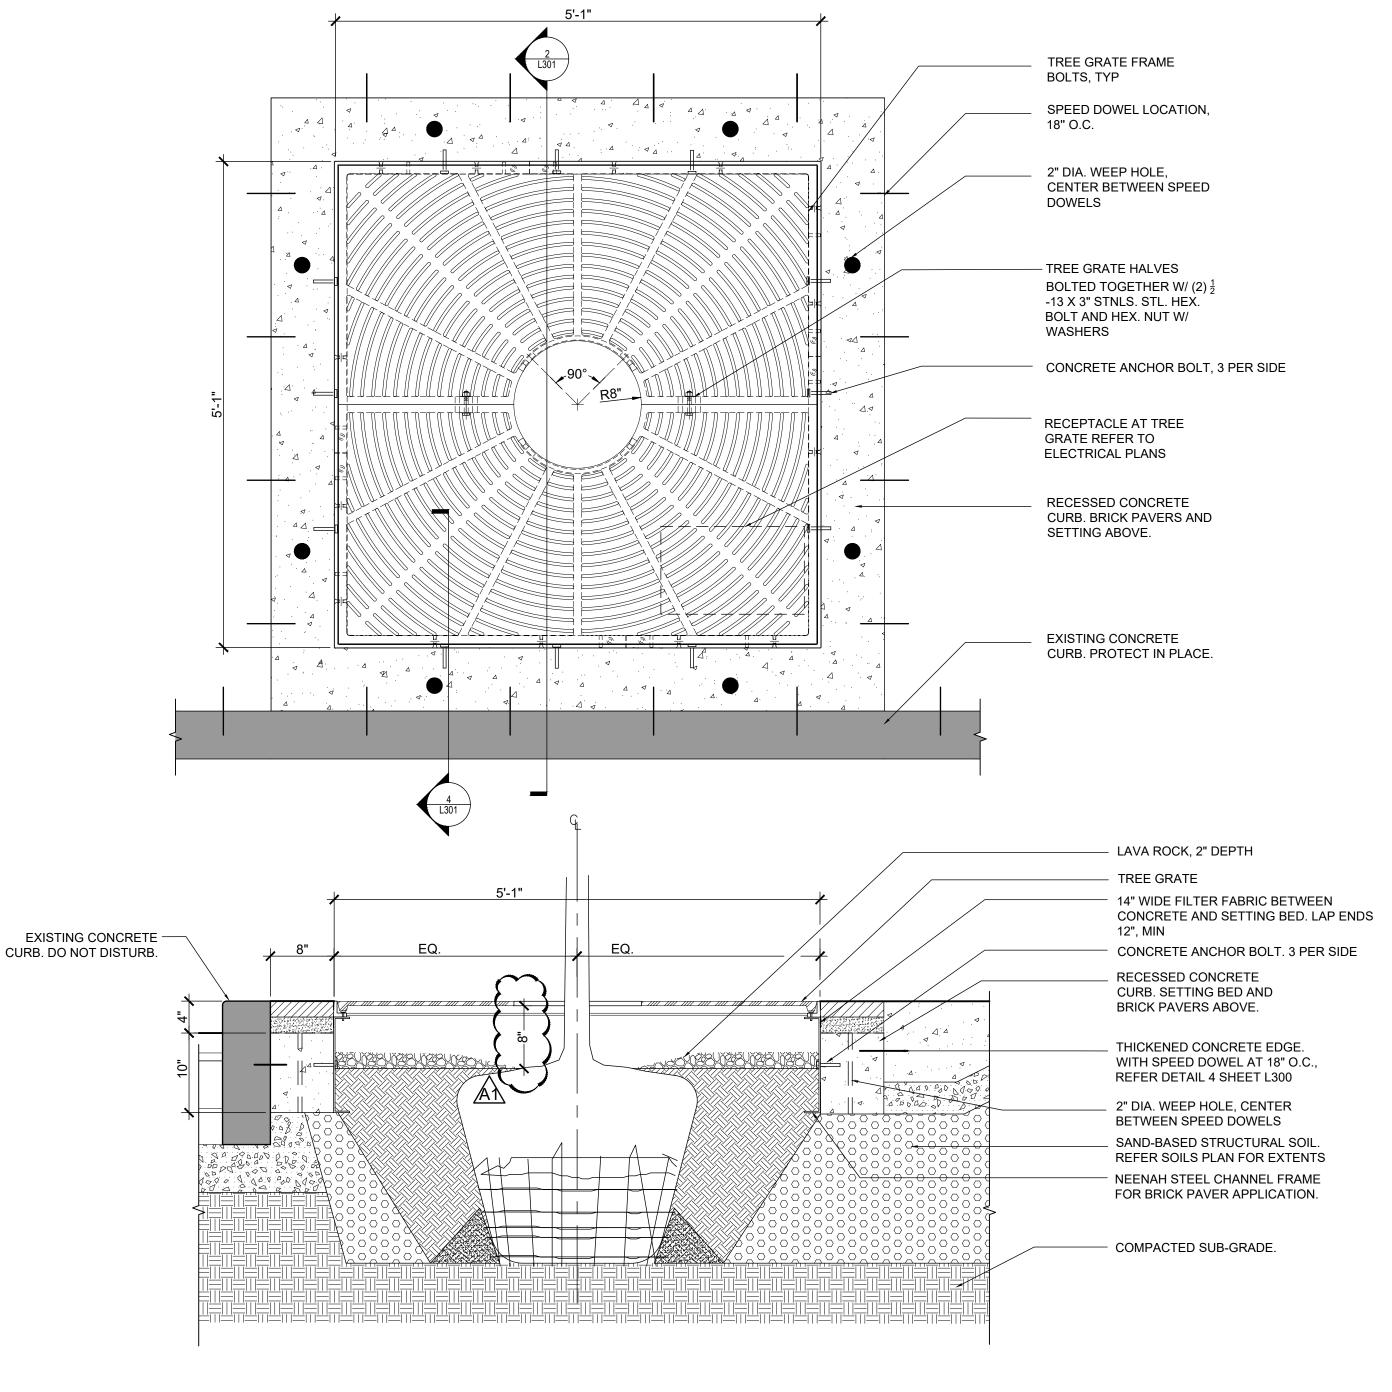

2 TREE GRATE - AT EXISTING CURB SCALE: 1" = 1'-0"

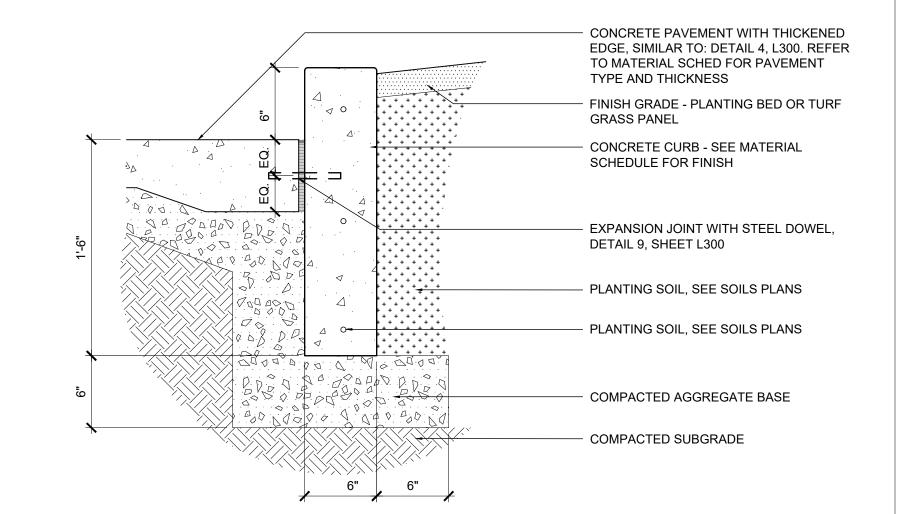

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> Architect for Larimer Park Booth Hansen

333 South Desplaines Street Chicago, IL 60661 p 312 869.5000

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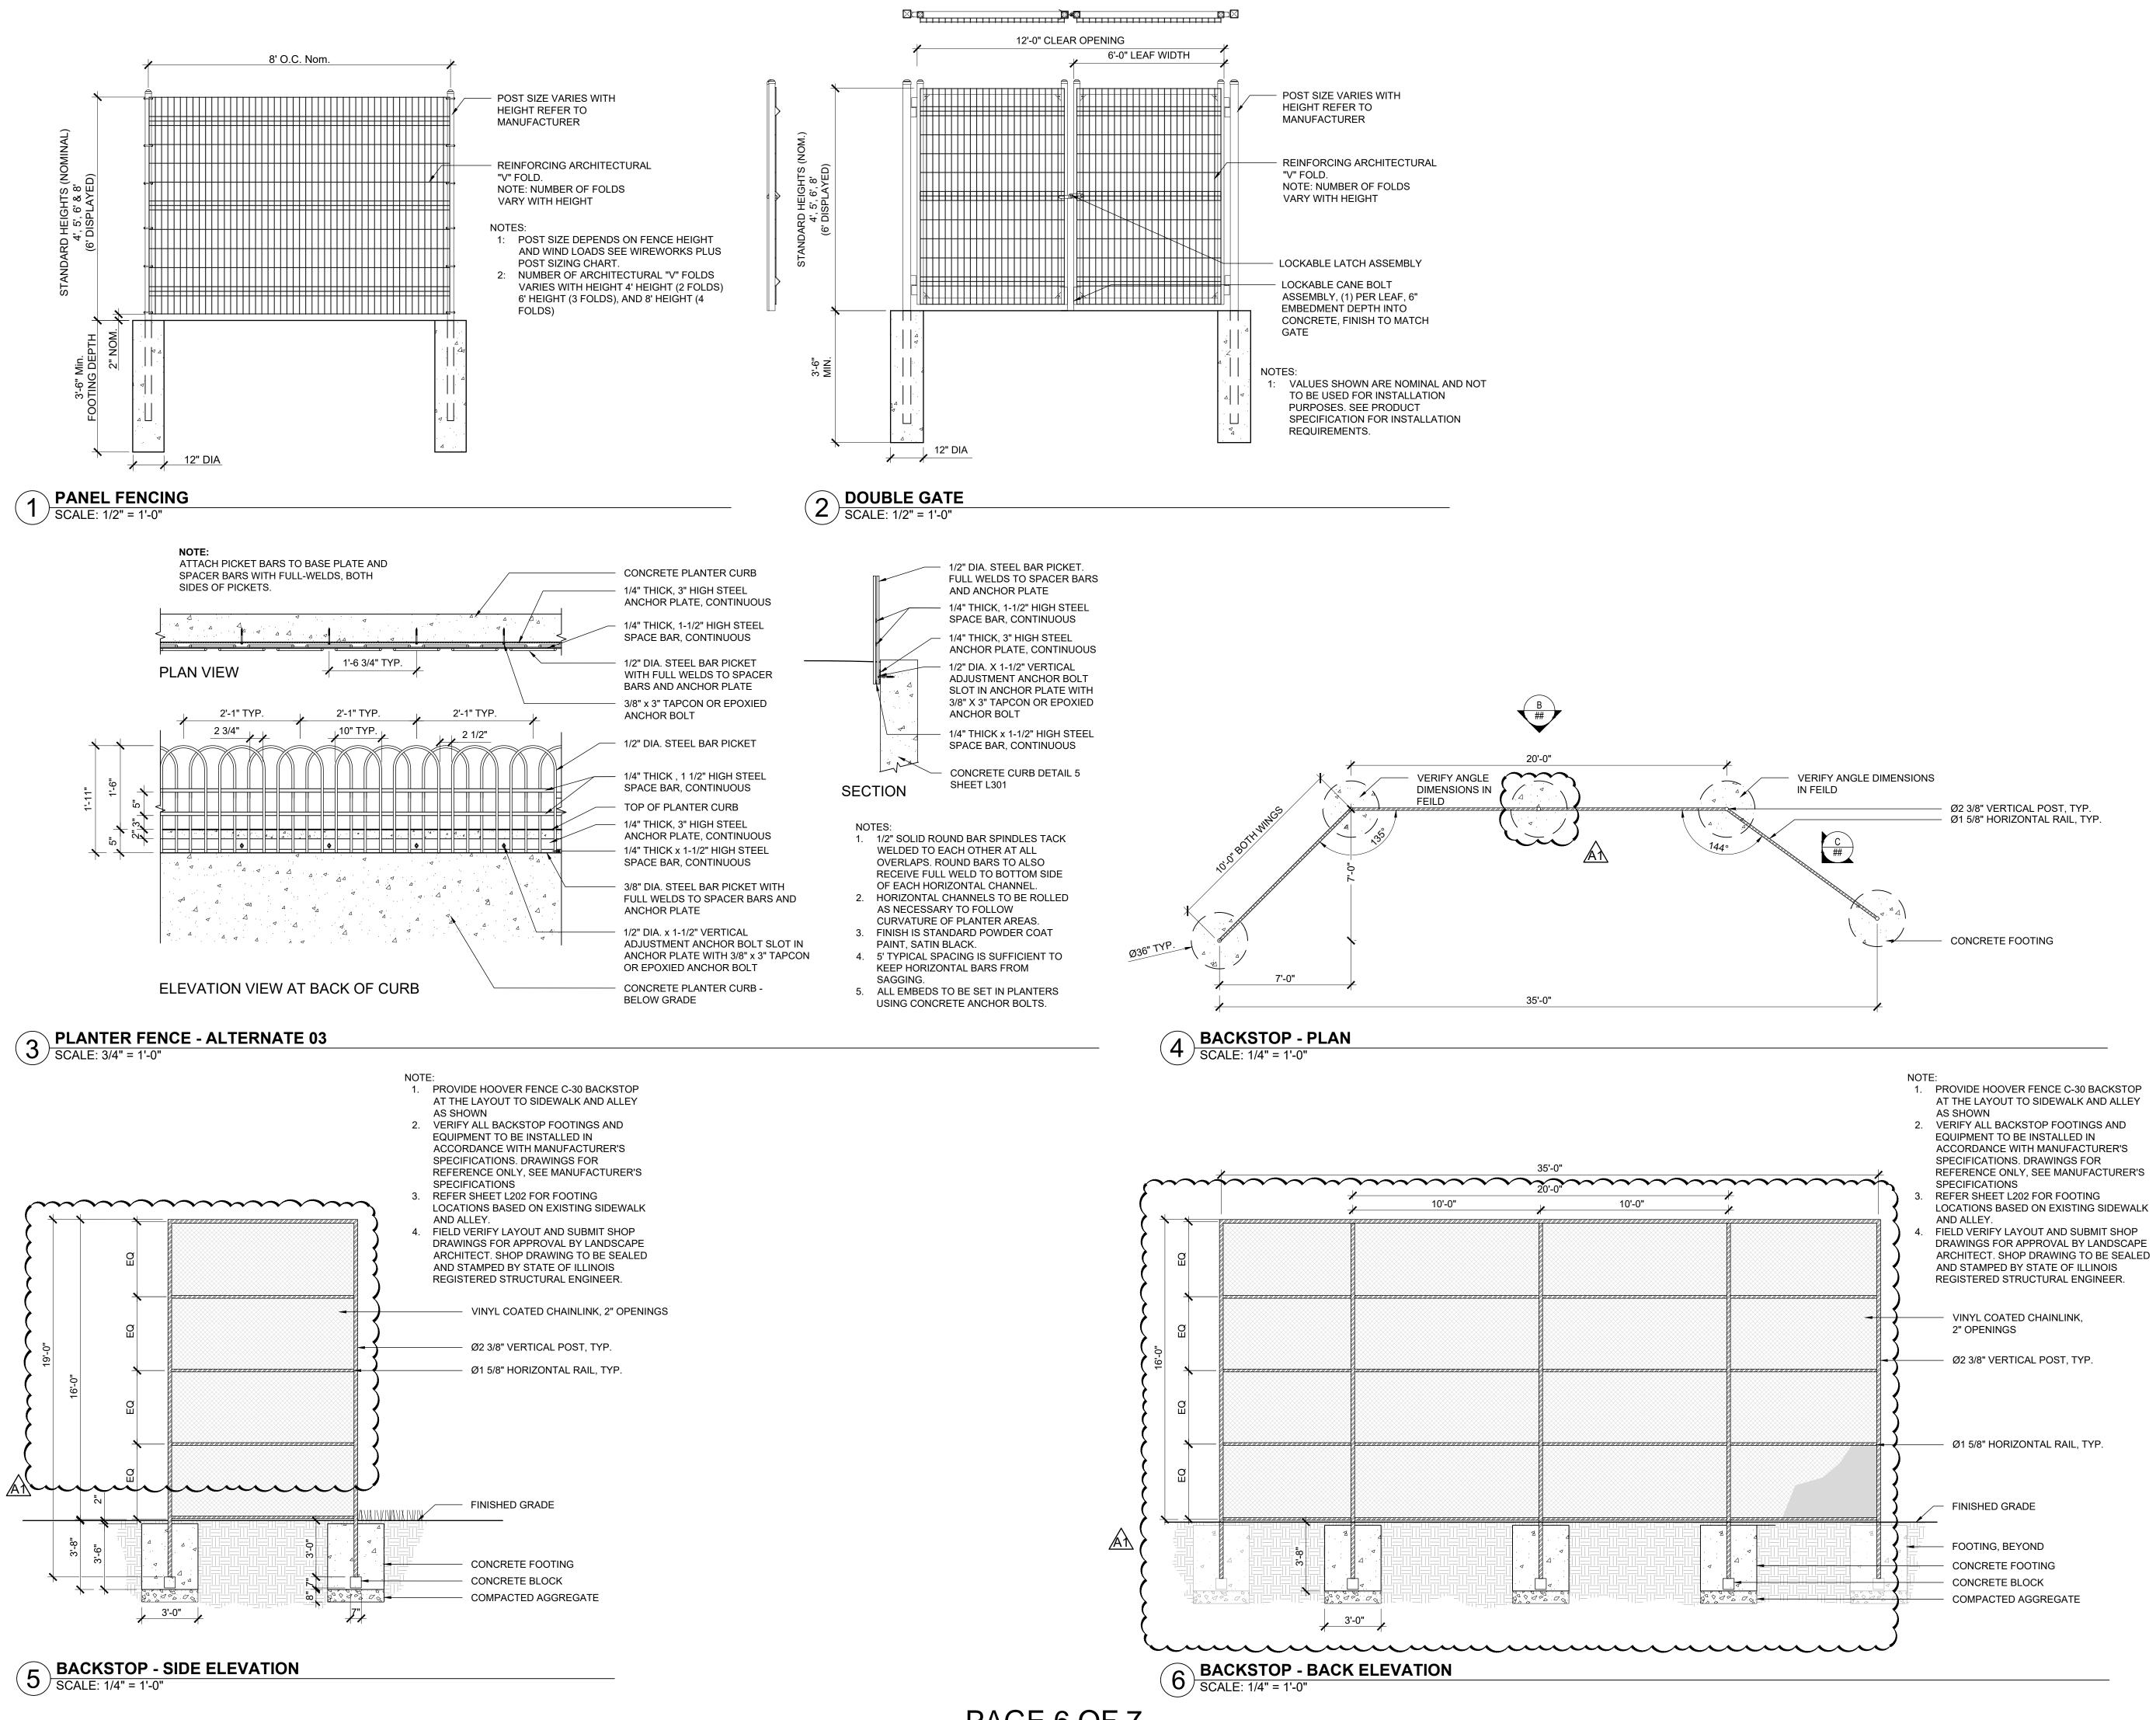
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SITE DETAILS

sheet number



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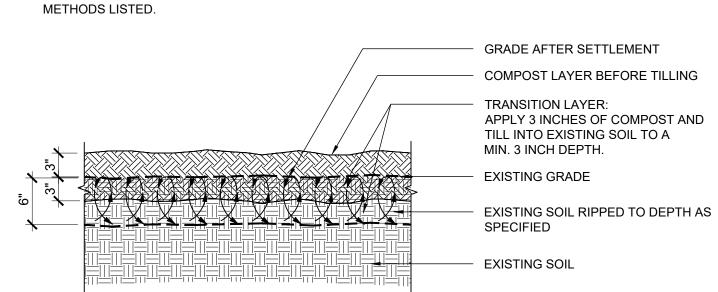
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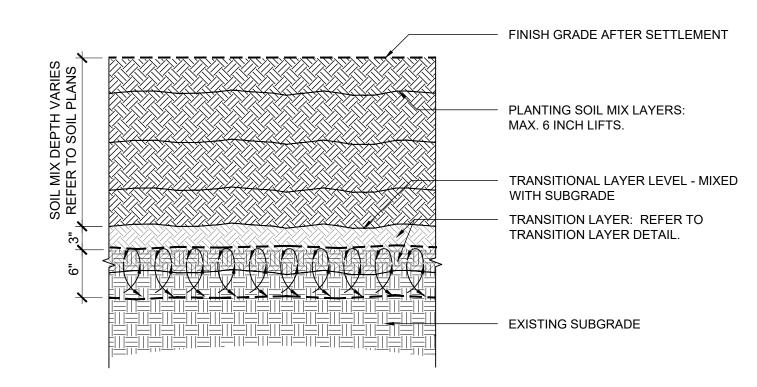
SITE DETAILS

sheet number


TRANSITION LAYER NOTE: DIMENSIONS AND MATERIALS LISTED ARE FOR GENERAL REFERENCE. REFER TO SPECIFICATIONS FOR RELATIVE AND RELATED INFORMATION TO EACH MATERIAL ITEM AND



SOIL MIX INSTALLATION NOTE: INSTALL PLANTING SOIL MIX AFTER TRANSITION LAYER HAS BEEN COMPLETED AND COMPACTED TO SPECIFICATIONS. REFER TO SOIL PLANS FOR SOIL MIX TYPE AND REQUIRED SOIL MIX DEPTH.



SEE PLANTING SOIL MIX SPECIFICATIONS FOR ADDITIONAL REQUIREMENTS.

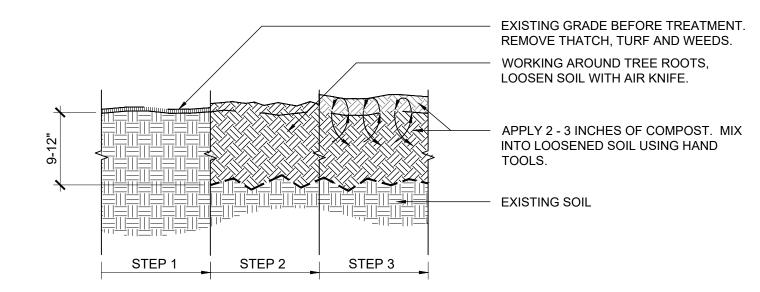

SOIL: TRANSITION LAYER - SUBGRADE PREPARATION SCALE: 1" = 1'-0"


NOTES:

- 1. SET TREE PLUMB IN PLANTING PIT.
- 2. EACH TREE MUST BE PLANTED SUCH THAT THE TRUNK FLARE IS VISIBLE AT THE TOP OF THE ROOT BALL. TREES WHERE THE TRUNK FLARE IS NOT VISIBLE SHALL BE REJECTED. DO NOT COVER THE TOP OF THE ROOT BALL WITH SOIL.

PLANTING SOIL MIX INSTALLATION

SCALE: 1" = 1'-0"

3. REFER SHEET PLANTING PLAN FOR ADDITIONAL PLANTING NOTES.

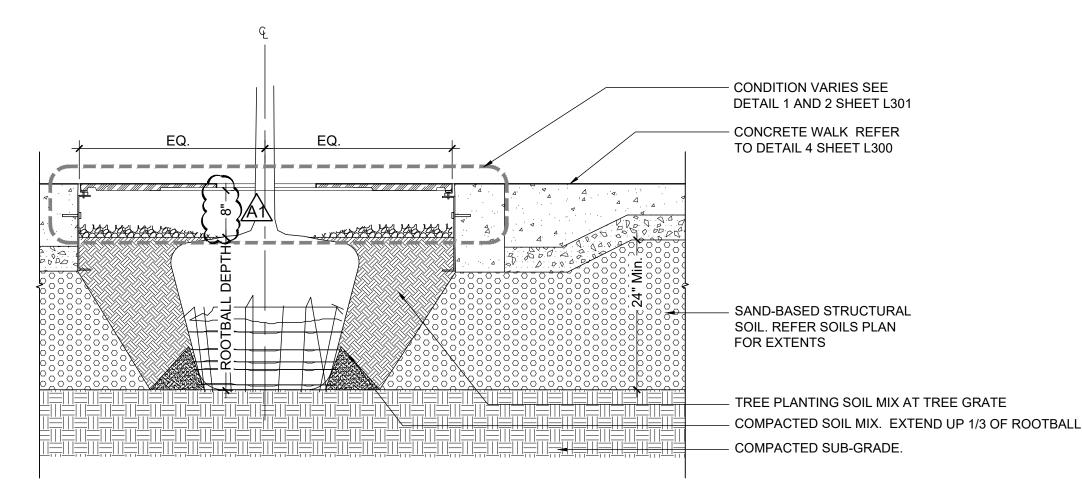

TREE PLANTING IN TREE GRATE

SCALE: 3/4" = 1'-0"

3 AMENDED SOIL WITHIN TREE DRIPLINE
SCALE: 1" = 1'-0"

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SOIL DETAILS

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